

A JT 07.01.20 Minor amendments

REV BY DATE DESCRIPTION

## SKETCH

## DESIGN + PLANNING

CLIENT PROJECT  DRG NAME Proposed Plans & Elevations  SCALE As Shown @ A1  DATE 08/12/20  JOB# 2000  DWG# 02 A  STATUS Planning  CONTACT jonathan@sketchplanningstudio.co.uk		
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JOB# 2000  DWG# 02 A  STATUS Planning	SCALE	As Shown @ A1
DWG# 02 A STATUS Planning	DATE	08/12/20
STATUS Planning	JOB#	2000
2 C. T. C.	DWG#	02 A
CONTACT jonathan@sketchplanningstudio.co.uk	STATUS	Planning
	CONTACT	jonathan@sketchplanningstudio.co.uk

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NOTES:-

All drawings to be read in conjunction with Structural Engineer's details & any relevant sub-contractor's details. All works to comply with current Building


3. Contractor to ensure that all work meets the requirements of the EHO, Building

Regulations, British Standards & Codes of Practice.

Control, Fire Authority and all other statutory bodies.

2. All dimensions to be checked on site prior to any works commence.

- All drawings to be read in conjunction with Structural Engineer's details & any relevant sub-contractor's details. All works to comply with current Building Regulations, British Standards & Codes of Practice.
- 2. All dimensions to be checked on site prior to any works commence.
- 3. Contractor to ensure that all work meets the requirements of the EHO, Building Control, Fire Authority and all other statutory bodies.

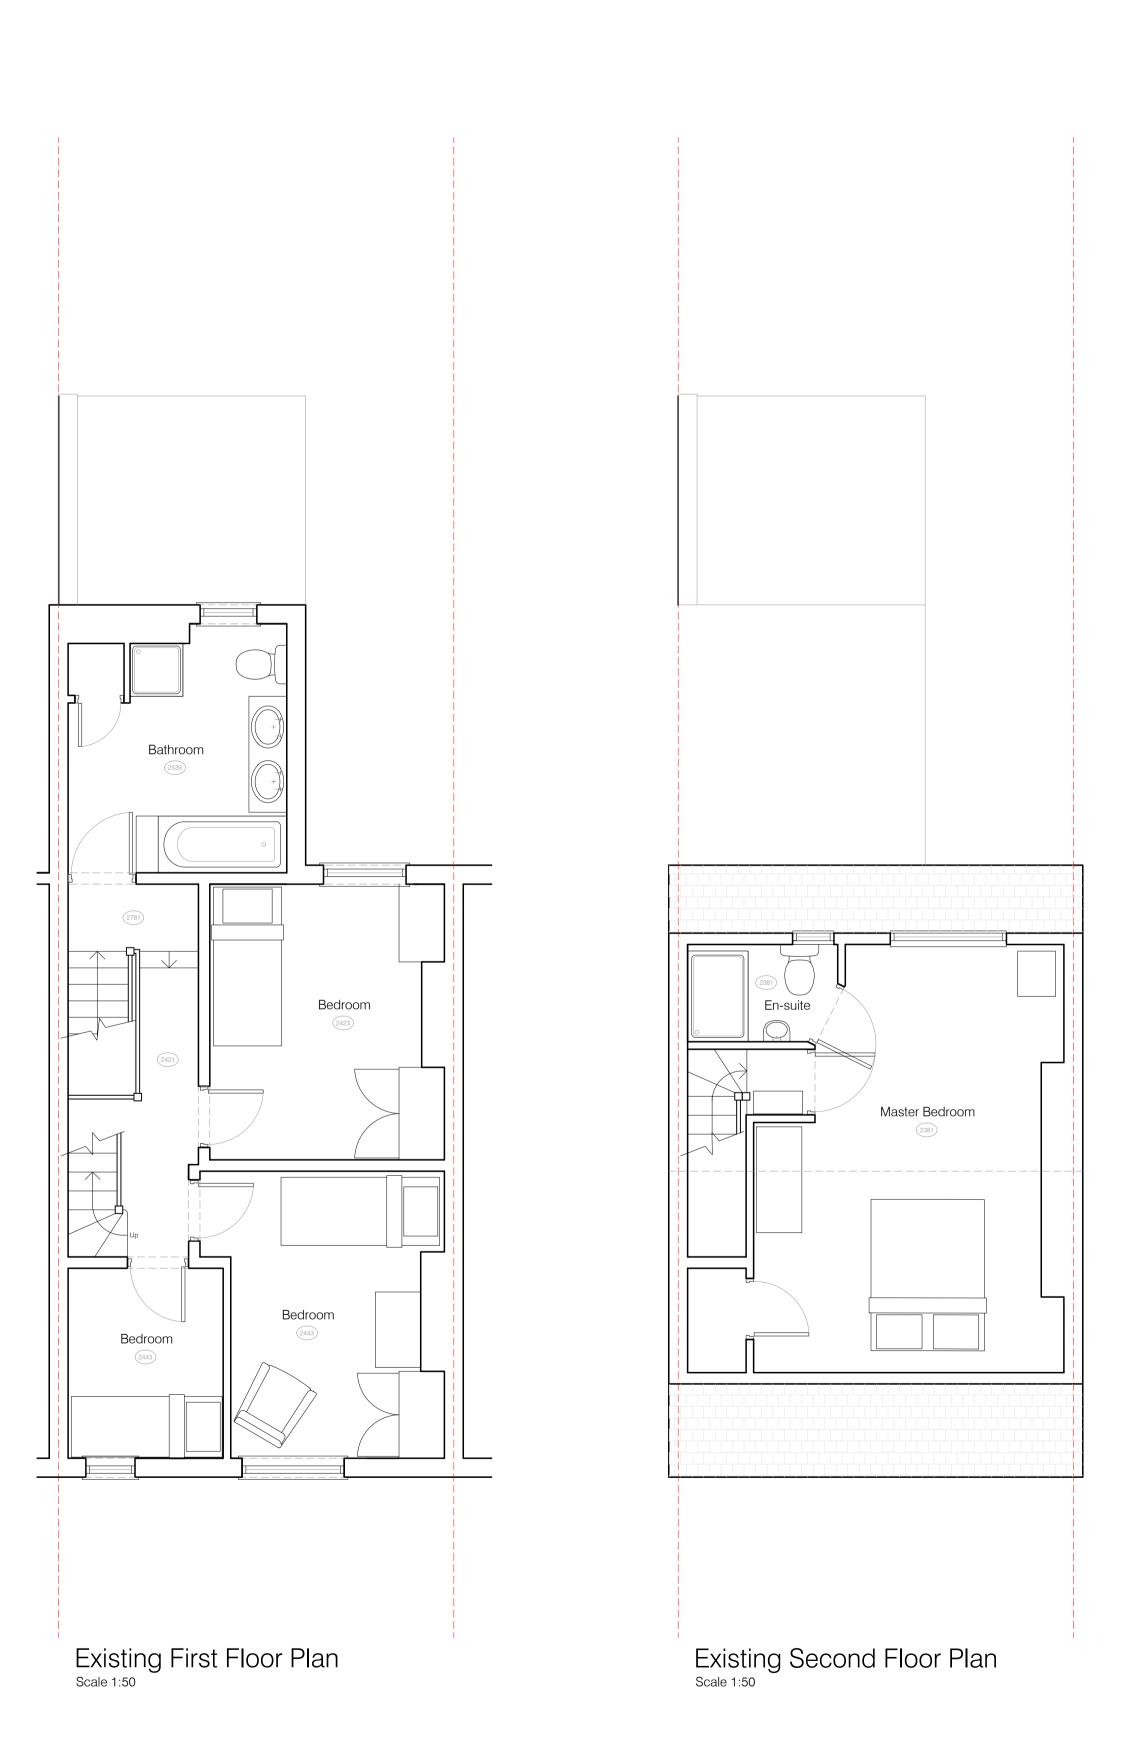


3267

Dining (2866) 2803

Existing Ground Floor Plan
Scale 1:50



Existing Front Elevation
Scale 1:50

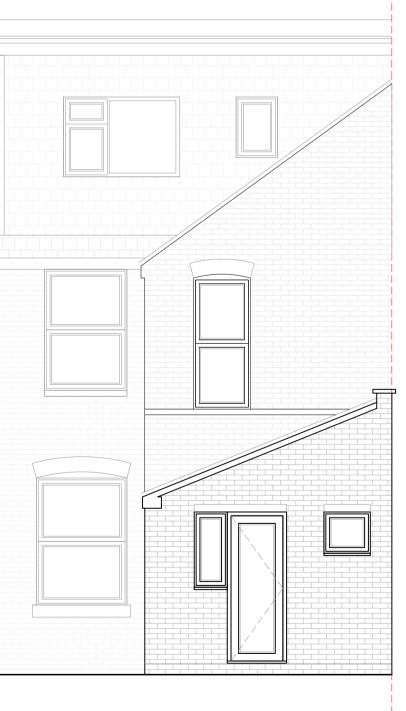

Existing Rear Elevation
Scale 1:50



## SKETCH DESIGN + PLANNING

(	CLIENT	
F	PROJECT	
	ORG NAME	Existing Plans & Elevations
5	SCALE	As Shown @ A1
	DATE	08/12/20
	JOB#	2000
	DWG#	01
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